CONTRACTOR NOTES:

DRAWING TO BE READ IN CONJUNCTION WITH CONTRACT

- DRAWINGS AND SPECIFICATIONS. THE REQUIREMENTS HEREIN SHALL BE COMPLIED WITH, WHETHER BY THE HEAD CONTRACTOR OR ELECTRICAL SUB-CONTRACTOR. CONTRACTORS SHOULD BE EXPERIENCED IN THIS WORK AND SHALL MEET LISTED WP QUALIFICATIONS.
- SUPPLY & INSTALL ALL WORKS AS SHOWN ON THESE DRAWINGS, TO PROVIDE A COMPLETE AND WORKING SYSTEM. COMPLETE ALL ASSOCIATED WORKS.
- ALL WORKS SHALL COMPLY WITH WESTERN POWER (WP) POLICIES, INCLUDING THE UDS, WASIR, DDC, DSPM, DCSH, UCIM AND EARTHING FAQ. ALL MATERIALS USED MUST BE APPROVED WESTERN POWER MATERIALS.
- COMPLY WITH ALL REQUIREMENTS OF THE LOCAL GOVERNMENT
- AUTHORITY (LGA) AND MAIN ROADS WA (MRWA) (IF APPLICABLE). VERIFY ALL MATERIAL QUANTITIES AGAINST SITE CONDITIONS PRIOR TO TENDER AND ADVISE THE PRINCIPAL OF ANY VARIATIONS IN TENDER OFFER.
- PREPARE AND COMPLY WITH A SITE SAFETY MANAGEMENT PLAN, INCORPORATING REQUIREMENTS OF WP'S ESSR AND ALL APPLICABLE LAWS & REGULATIONS
- FOR ALL WORKS IN PROXIMITY OF EX SERVICES AND ASSETS: ACQUIRE CURRENT DBYD DRAWINGS. LOCATE UG SERVICES AS NECESSARY USING APPROPRIATE TECHNIQUES (GROUND PENETRATING RADAR, HAND & VACUUM POT-HOLING ETC). COMPLY WITH THE REQUIREMENTS OF ALL SERVICE PROVIDERS FOR WORKS IN PROXIMITY TO THEIR SERVICES AND AQUIRE REQUIRED PERMITS FOR WORK.PLAN FOR AND PROTECT EXISTING SERVICES IN THE VICINITY OF ALL WORKS.DO NOT ENCROACH MINIMUM APPROACH DISTANCES FOR UG OR OH SERVICES.
- LIAISE WITH WP AS REQUIRED. ATTEND PRE-HANDOVER INSPECTION WITH WP AND RECTIFY ALL DEFECTS. COMPLETE HANDOVER PROCESS FOR ALL NETWORK TO WP.
- D. LIAISE WITH SUPERINTENDENT AND NOMINATED ELECTRICAL INSPECTOR AS REQUIRED. HOST A PRE-START MEETING AND FACILITATE PERIODIC ON SITE WORK PROGRESS QA INSPECTIONS WITH SUPERINTENDENT AND/OR INSPECTOR.
- TRENCH, BACKFILL AND RE-INSTATE (MAKE GOOD) ALL SURFACES. 2. LEAVE SUFFICIENT CABLE COILED AT ALL INTERFACE POINTS (INCLUDING JOINTS PILLAR TERMINATIONS & POLE TERMINATIONS) TO ALLOW WP TO COMPLETE INTERFACE WORKS. INSTALL END CAPS TO PROTECT CABLE. BRING NEW CABLE ADJACENT TO EXISTING CABLE AND POT-HOLE TO EXPOSE
- EXISTING CABLES FOR WP AT HANDOVER. WHERE RETAINING WALLS, OR ANY WALL THAT COULD BE A COLLAPSE RISK DURING EXCAVATION ARE PROPOSED INSTALL ALL ADJACENT CABLES IN CONDUITS. WHERE SUCH WALLS ARE EXISTING, DRILL CONDUITS PAST WALLS AND HAUL CABLE
- THROUGH CONDUITS. . AT ALL POINTS WHERE CABLES ARE NOT IN CONDUIT ADJACENT TO A WALL (BENDS, JOINTS ETC) INSTALL DEEPENED WALL FOOTINGS TO AT LEAST THE DEPTH OF THE ADJACENT CABLES
- 5. ALL CABLES INSTALLED OUTSIDE OF 0-0.5m ALIGNMENT TO BE IN CONDUIT, OR WITH CABLE SLABS ABOVE WHERE REQUIRED. 6. INSTALL SUITABLE RUST-FREE DRAW WIRES IN ALL SPARE
- PILLARS UNDER RETAINING WALLS. . BORE UNDER EXISTING ROADS AND DRIVEWAYS. HAND PLUNK UNDER FOOTPATHS ETC WHERE SUITABLE.

CONDUITS INCLUDING CONSUMER-MAINS CONDUITS FROM

- B. STREETLIGHT POLES MUST NOT BE INSTALLED IN FOOTPATHS. PEG POLE LOCATIONS PRIOR TO INSTALL AND NOTIFY THE SUPERINTENDENT OF CLASHES IN ADVANCE.
- . STREETLIGHT POLES SHALL BE PLUMB VERTICAL AND GROUND AROUND POLES COMPACTED TO CIVIL SPECIFICATION AFTER
- 20. ERECT STREETLIGHT POLES ONLY AFTER NEARBY EXISTING OVERHEAD POWERLINES ARE REMOVED, WHERE NOTED.
- 21. COMPLETE CLEARING/TRIMMING OF EXISTING VEGETATION AT WP INTERFACE WORKS LOCATIONS. 2. COMPLETE ALL TESTING AS PER WP REQUIREMENTS AND
- PROVIDE TEST DOCUMENTATION AND HANDOVER CHECKLIST TO THE SUPERINTENDENT OR NOMINATED ELECTRICAL INSPECTOR. 3. COMPLETE AS CONSTRUCTED PACKAGE TO THE AS PER UDS &
- PROVIDE TO THE SUPERINTENDENT. ENGAGE 3E CONSULTING ENGINEERS TO PREPARE WP COMPLIANT CAD AS CONS DRAWINGS. INCLUDE 3E's COSTS FOR DRAFTING AS CON DRAWINGS IN TENDER PRICE. MAINTAIN AND PROVIDE COMPLETE, CLEAR & LEGIBLE RED-LINE AS CONSTRUCTED DRAWING MARK-UPS TO 3E.
- 24. WHERE NOTED, INSTALL STREETLIGHT ON 2.5m ALIGNMENT

<u>WESTERN POWER SCOPE OF WORKS</u>


- WP TO COST TO CARRY OUT WORKS DESCRIBED HERE, INCLUDING ALL ASSOCIATED WORKS AND SUPPLY OF ALL MATERIALS.
- (A) REMOVE EX LES/WORKING END AND STRAIGHT JOINT NEW 240LV CABLE TO EX 240LV CABLE.EXCAVATE & BACKFILL JOINT BAY & SUPPLY JOINT.
- B) DISCONNECT AND ABANDON EXISTING 35HV CABLE UPSTREAM AT SAPPHIRE ROAD S/GEAR.

CLIENT SCOPE/NOTES:

C1. PROJECT SURVEYOR REQUIREMENTS a) LOT BOUNDARY CREATION/MODIFICATION, INCLUDING ANY ROAD RESERVE EXTENSIONS FOR SUBSTATION SITES AND LIGHT POLES AS SHOWN ON THIS DRAWING.

b) CREATION OF ANY EASEMENTS, TITLE NOTIFICATIONS & RESTRICTIVE COVENANTS ETC AS

- SHOWN ON THIS DRAWING. 2. OBTAIN ALL RELEVANT ENVIRONMENTAL APPROVALS AND/OR CLEARING PERMITS FOR CLEARING OF FLORA IN AREA OF WP WORKS, AT AREAS SHOWN ON THIS DRAWING.
- B. WHERE NOTED, CIVIL DESIGN TO DEVIATE FOOTPATH AROUND LIGHT POLE.

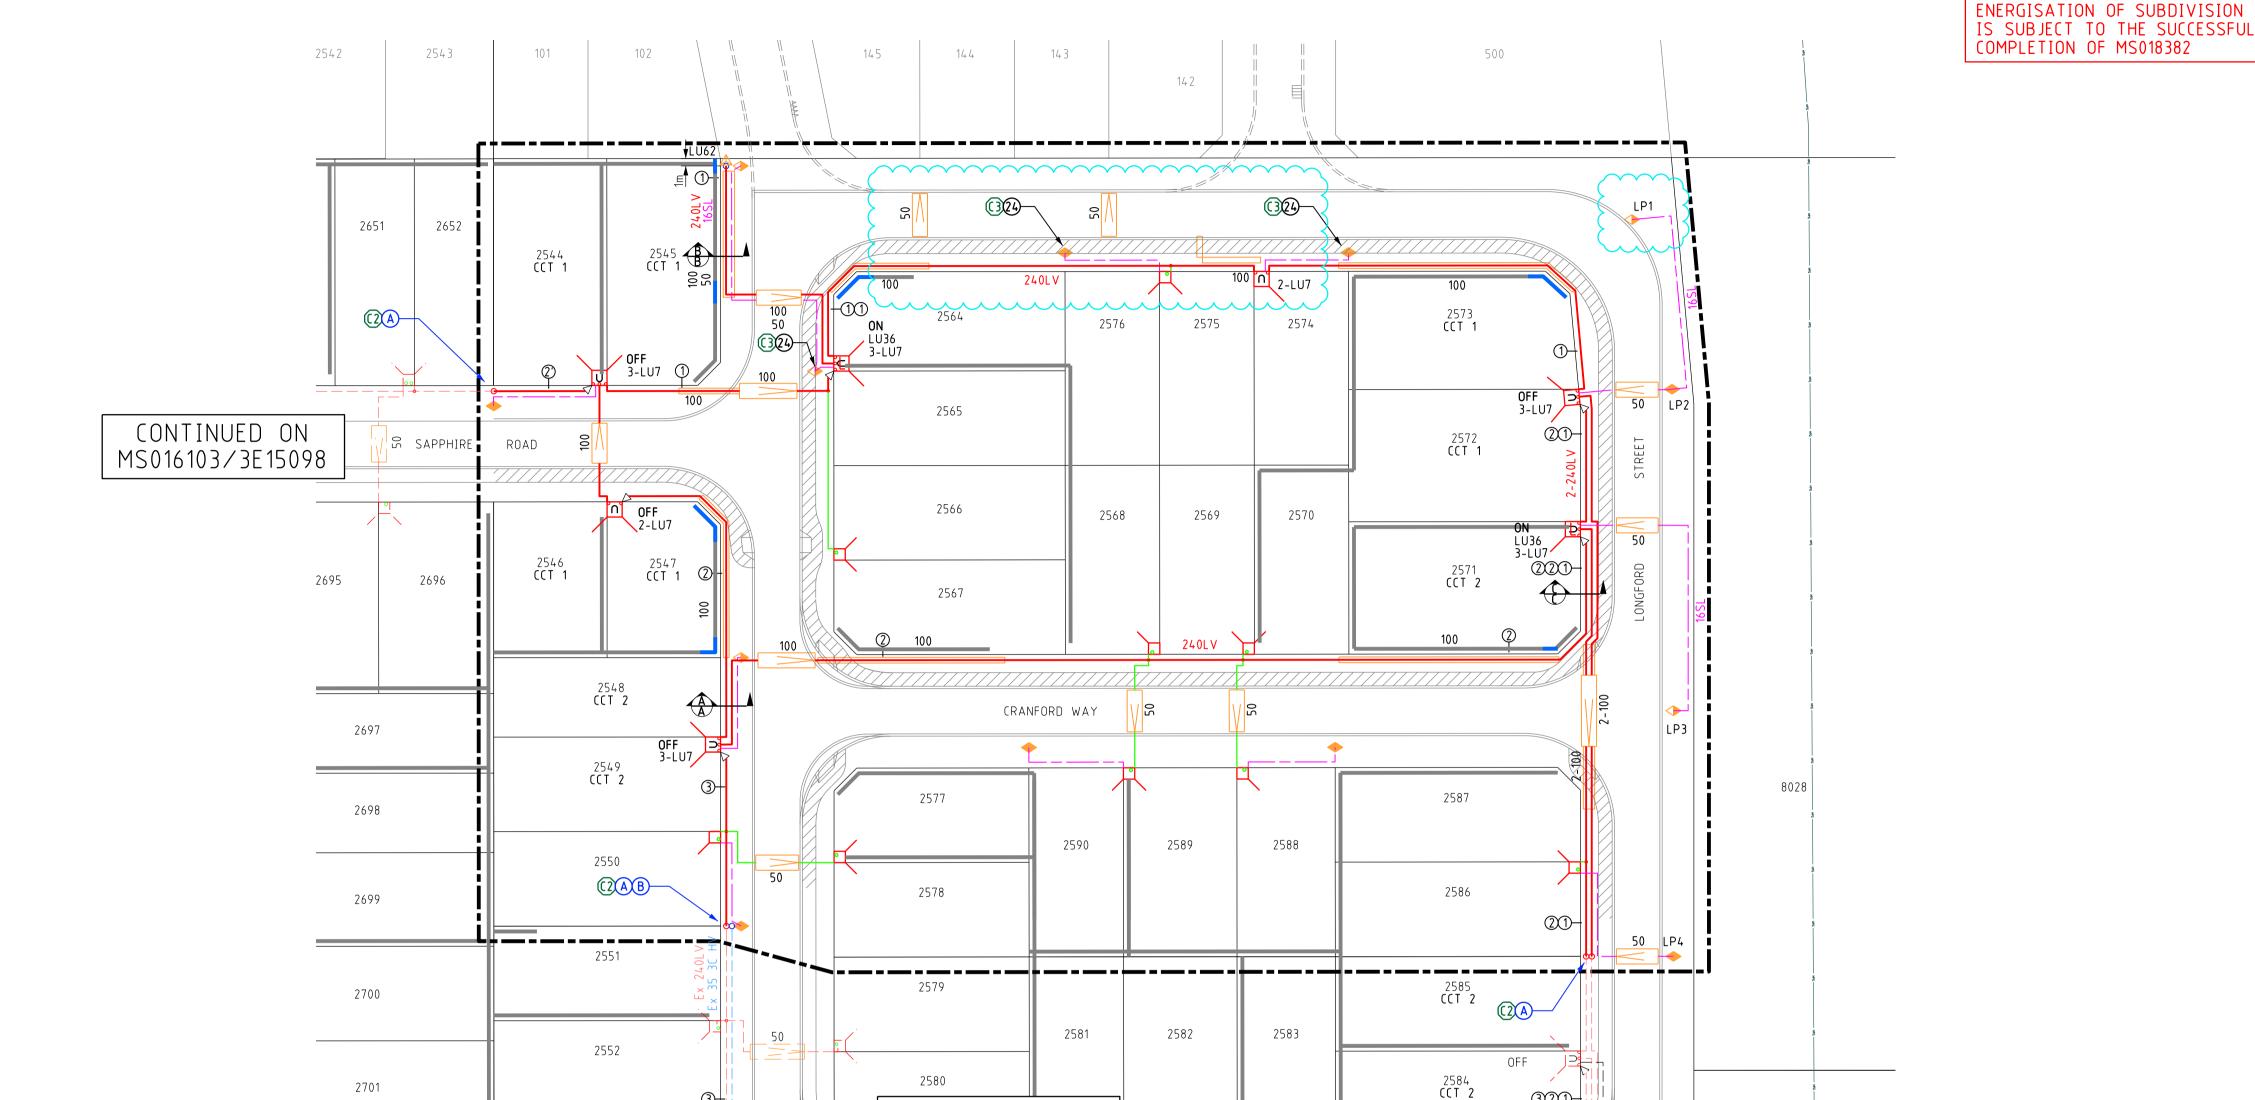



CONTINUED ON


MS018382/3E21097

*ASTERISK DENOTES CHANGE IN LOAD ON AN EXISTING CIRCUIT

AND TENDEN DENOTES CHANGE IN EARL THE CHOOL								
TRANSFORMER SPECIFICATIONS AND LOCATION	1 1/11/1	CIRCUIT NO.	FUSE AMPS	CABLE mm²	CIRCUIT NAME		AMPS	TOTAL AMPS
EXISTING 630kVA Tx POS 8030 22kV (827A)	1	×1	315	240	UNI LOT 2547 & L.E.S LOT 2545	11.78V	98A	
	2	×2	315	240	UNIS LOTS 2572 (OFF) & 2547 (OFF)	14.19 V	176A	
	3	×3	315	240	UNIS LOTS 2549 (OFF) & 2584 (OFF)	13.90V	176A	529A
ADMD: 4.7kVA	4	4	315	240	UNI LOT 2560 & UNI LOT 2598 (OFF)	12.25V	235A	
	5	5	315	240	UNI LOT 114 (OFF)	-	-	

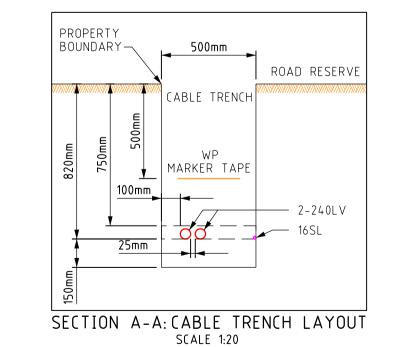

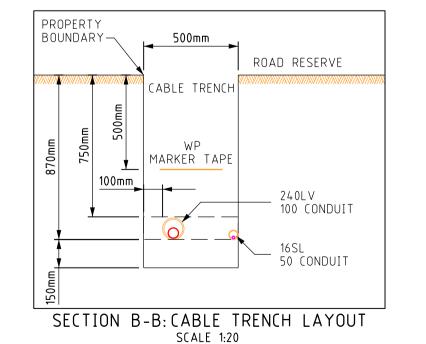

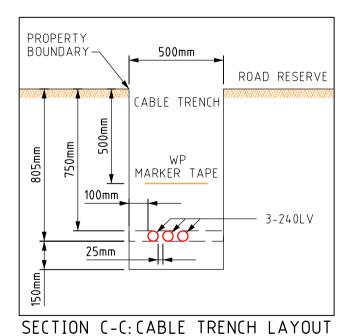

SCALE 1:20

LEGEND SCHEME BDY. ____ RETAINING WALL RETAINING WALL EXTRA FOOTING RESTRICTED ZONE EASEMENT HV CABLES

ARROW DENOTES DIRECTION TO PEG WITH

WHICH DUCTS ARE TO BE ALIGNED

DUCTS TO BE LAID TO WP SPECIFICATION AS OUTLINED

IN UNDERGROUND DISTRIBUTION SCHEMES MANUAL -

DENOTES PREVIOUSLY REQUESTED DUCTS


POLICY AND INSTALLATION OPTIONS


CN53 - 400mm2 (3X1c)	
CN49 - 240mm2 (3X1c)	
CN48 - 185mm2 (3X1c)	
CN50 - 95mm2 (3X1c)	
CN51 - 50mm2 (3X1c)	
CN51 - 50mm2 (1c)	
CN46 - 35mm2 (3X1c)	
CN47 - 35mm2 (1c)	
EXISTING HV CABLES (SIZE AND TYPE INDICATED)	
LV-SL	CABLES
CN45 - 240mm2 (1x3c)	

EXISTING HV CABLES (SIZE AND TYPE INDICATED)
LV-SL CABLES
CN45 - 240mm2 (1x3c)
CN44 - 185mm2 (1x3c)
CN43 - 120mm2 (1x3c)
CN42 - 25mm2 (1x3c)
CN41 - 16mm2 SL (1c)
40 C PILOT
EXISTING LV CABLES (SIZE AND TYPE INDICATED)
STREET LIGHTS LEGEND DEFINES TYPE & WATTAGE - NOT COLOUR
ROAD FLAIR ROAD FLAIR DECORATIVE LED 3000K LED 4000K LED 4000K ◆ 16W 1E ♦ 16W 1L ♦ 17W 1A

	LEGENO DE INE	5 5	
	ROAD FLAIR LED 3000K	ROAD FLAIR LED 4000K	DECORATIVE LED 4000K
	◆ 16W 1E	<>> 16W 1L	<>> 17₩ 1A
	◆ 43W 2E	◆ 42W 2L	◆ 42W 3A
	◆ 28W 3E	<→ 27W 3L	≪ 80W 4C
	→ 70W 4E	<>> 68₩ 4L	◆ 100W 5C
	◆ 140W 5E	◆ 135W 5L	◆ 155W 6C
	♦ 165W 6E	◆ 155W 6L	
Π	SUPERS	DED DISCHARGE LUMIN	NAIRES
	→ 42W CFL	70W HPS	∠ 70W MH
	⊕ 80W MV	150W HPS	<u></u> 150₩ MH
	125W MV	250W HPS	≜ 250W MH
	() ENGETHIC	<u></u>	

(_) EXISTING A250W	HPS AERODROME
PILLARS / PI	TS / ETC
MINI (WORKING END)	UMS PIT
U UNIVERSAL	CONCRETE
□ MINI □	# P# - TYPE
LINK	B/D - TRAFFICABLE
	LID RATING
MARKER POST	☐ 100/200AMP CUTOUT
CUSTOM FOOTPATH CABLE MARKER PLATE	SERVICED UNCLEARED DE-ENERGISED LOT
CONDUIT / POLY PIPE	EXISTING SUDL LOT, TO BE ENERGISED NOW

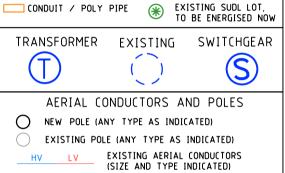

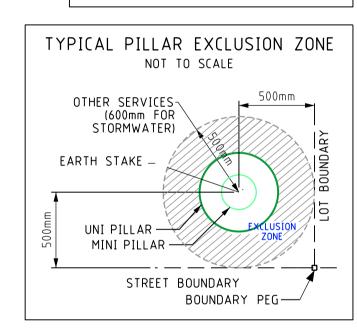

			·	
0	CIVIL BASE UPDATED, DESIGN UPDATED TO SUIT FUTURE INTERCONNECTION. ISSUED TO WP FOR CONFORMANCE	07.02.2022	DA	VH
А	ISSUED TO CLIENT FOR COMMENT	24.01.2022	DA	VH
REV	DESCRIPTION	DATE	DRWN	CHKD



Suite 1, Level 2, Condor Tower 22 St George's Tce, Perth WA 6000 PO Box 3184 East Perth WA 6892 Tel: 08 6314 9000 Email: admin@3ece.com.au

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REFER TO 'WORKSAFE' REGULATION

LAT 31° 51′ 02″ S LONG 115° 58′ 50″ E

\bigwedge	0 5 10	20	30	40
/ \	Scale	1:500	a A1 Origina	al Paper Size
T 31° 51′ 02″ S	Base File Date	02-02-2022	H. Datum	PCG94
	Designed: DA	Drawn: DA	Checked: JH	Appr: JH
	Western Power Reference No.	TBA	WAPC No.	160731
IG 115° 58′ 50″ E	Local Authority	CITY OF SW	/AN	

Civil Consultant TABEC

ST LEONARDS ESTATE, DAYTON - STAGE 1W 27 RESIDENTIAL LOTS ELECTRICAL NETWORK

Sheet Of 3E Drawing Number 3E 22009 - 01

CONTRACTOR NOTES:


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- COMPLETE, CLEAR & LEGIBLE RED-LINE AS CONSTRUCTED DRAWING MARK-UPS TO 3E. 24. WHERE NOTED, INSTALL STREETLIGHT ON 2.5m ALIGNMENT

WESTERN POWER SCOPE OF WORKS


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CLIENT SCOPE/NOTES:


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- DRAWING. B. WHERE NOTED, CIVIL DESIGN TO DEVIATE FOOTPATH AROUND LIGHT POLE.

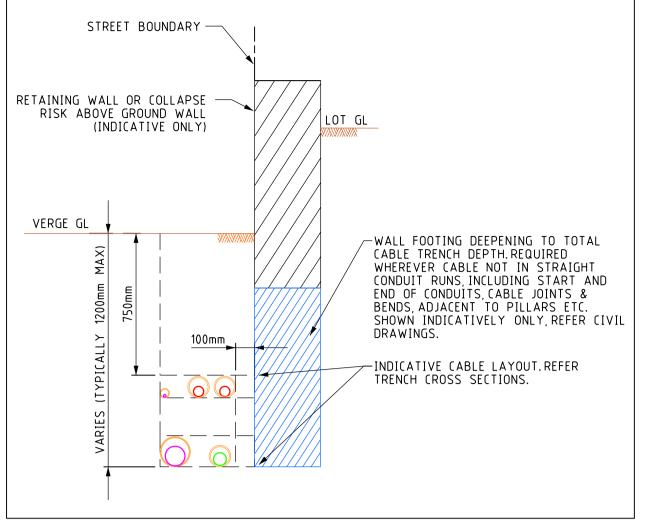


TYPICAL WALL FOOTING DEEPENING ARRANGEMENT NOT TO SCALE

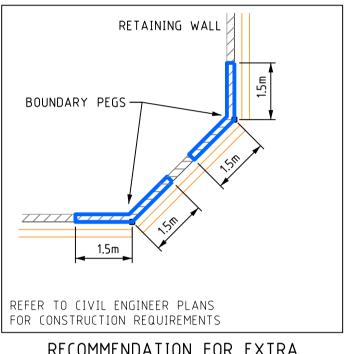


RECOMMENDATION FOR EXTRA RETAINING WALL FOOTINGS TO ALLOW CABLE PULL NOT TO SCALE

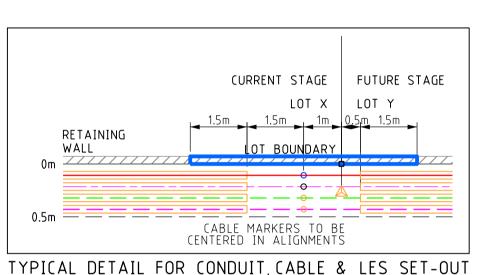

AT PROJECT BOUNDARY ADJACENT TO WALL NOT TO SCALE

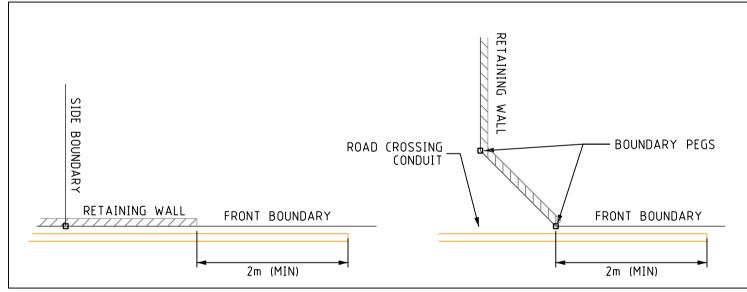

MINIMUM CONDUIT EXTENSION AT WALLS TO AVOID DEEPENED FOOTINGS NOT TO SCALE

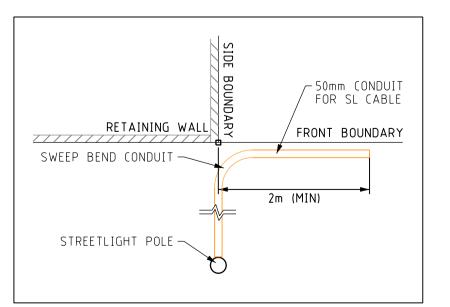


SL POLE CONDUIT TO AVOID DEEPENED FOOTINGS

NOTES:


- 1. FOR STREET LIGHT POLES WITHOUT REFERENCE POINTS TO LOCATE REFER TO THE COORDINATE TABLE BELOW.
- 2. SEPARATION DISTANCES LISTED ARE MINIMUM REQUIREMENTS, NOT REFERENCES FOR SET-OUT.ENSURE
- CLEARANCES ARE MET AFTER PEGGING ON SITE TAKING INTO ACCOUNT POLE DIAMETER. 3. POLE LOCATION COORDINATE POINTS TAKEN OFF THE CADASTRAL DRAWING PROVIDED BY CIVIL CONSULTANT. LOCATIONS TO BE CONFIRMED BY SURVEYOR ON SITE.

STREET LIGHT POLE LOCATION SUMMARY					
HORIZONT	HORIZONTAL DATUM: PCG94				
POLE	EASTING	NORTHING	NOTES		
LP1	65565.1595	274887.5323	1m TO TOE OF KERB		
LP2	65570.4573	274865.1075	2.7m ALIGNMENT		
LP3	65570.6483	274822.5881	2.7m ALIGNMENT		
LP4	65570.6478	274790.1076	2.7m ALIGNMENT		

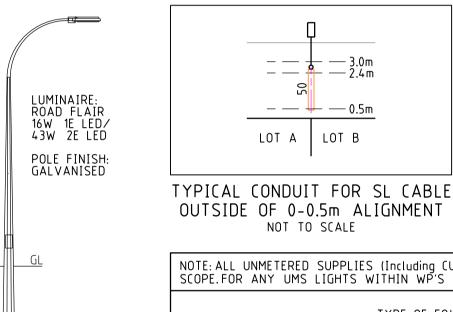


WP STANDARD 6.5m

SINGLE OUTREACH POLE NOT TO SCALE

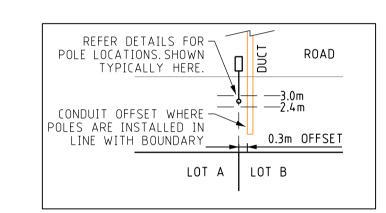

TYPICAL ROAD CROSSING NEAR LIGHT POLE ARRANGEMENT NOT TO SCALE

NOTE: ALL UNMETERED SUPPLIES (Including CUSTOMER AND WESTERN POWER STREETLIGHTING ASSETS) CONNECTED TO UNDERGROUND SYSTEM IN CONTRACTOR'S SCOPE. FOR ANY UMS LIGHTS WITHIN WP'S SCOPE, REFER TO WP DRAWINGS FOR UMS LOAD DETAILS.							
TYPE OF EQUIPMENT			UNIT WATTAGE		DAILY HRS OPERATION		
6.5m STANDARD POLE + ROAD FLAIR 16W 1E	•	8	16 W	128W	DUSK/DAWN	YES	
6.5m STANDARD POLE + ROAD FLAIR 43W 2E		5	43W	215W	DUSK/DAWN	YES	

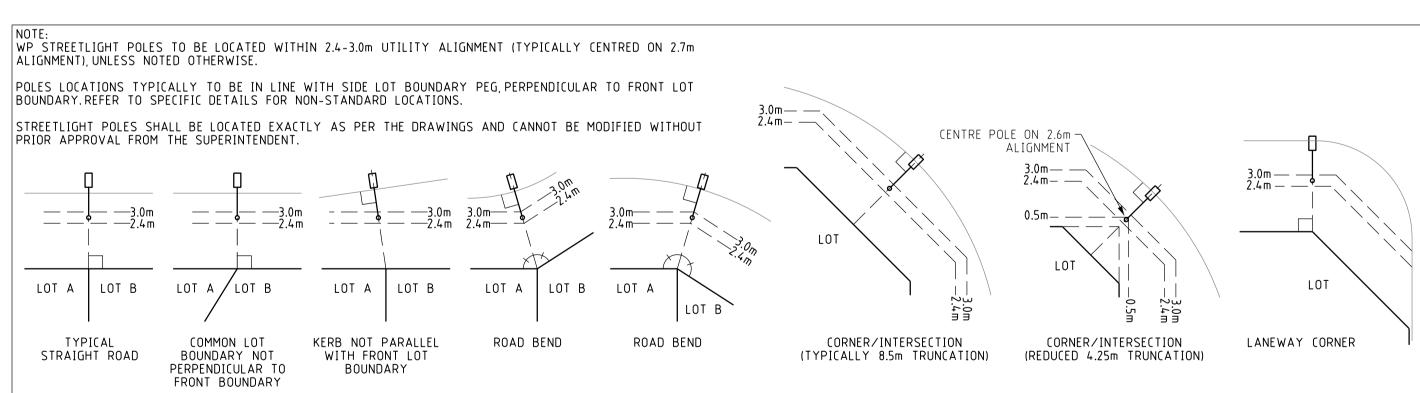

TYPICAL STREETLIGHT POLE LOCATIONS

NOT TO SCALE

0	CIVIL BASE UPDATED, DESIGN UPDATED TO SUIT FUTURE INTERCONNECTION. ISSUED TO WP FOR CONFORMANCE	07.02.2022	DA	VH
А	ISSUED TO CLIENT FOR COMMENT	24.01.2022	DA	VH
REV	DESCRIPTION	DATE	DRWN	СНК



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LAT 31° 51′ 02″ S LONG 115° 58′ 50″

Λ	0 5 10	20	30	40
AT 31° 51' 02" S NG 115° 58' 50" E	Scale	1:500	a A1 Origina	al Paper Size
	Base File Date	02-02-2022	H. Datum	PCG94
	Designed: DA	Drawn: DA	Checked: JH	Appr: JH
	Western Power Reference No.	TBA	WAPC No.	160731
	Local Authority	CITY OF SWAN		
	Civil Consultant	TABEC		

ST LEONARDS ESTATE, DAYTON - STAGE 1W 27 RESIDENTIAL LOTS

LEGEND

HV CABLES

CN53 - 400mm2 (3X1c) — — — — -

(N49 - 240mm2 (3X1c) — — — — —

CN48 - 185mm2 (3X1c) — — — — —

CN50 - 95mm2 (3X1c) — — — — -

CN51 - 50mm2 (3X1c) — — — — —

CN46 - 35mm2 (3X1c) — — — — —

CN47 - 35mm2 (1c) -----

LV-SL CABLES

STREET LIGHTS LEGEND DEFINES TYPE & WATTAGE - NOT COLOUR

ROAD FLAIR

LED 4000K

<>> 16₩ 1L

<>> 68₩ 4L

◆ 155W 6L

SUPERSEDED DISCHARGE LUMINAIRES

70W HPS

PILLARS / PITS / ETC

TRANSFORMER EXISTING SWITCHGEAR

AERIAL CONDUCTORS AND POLES

EXISTING AERIAL CONDUCTORS

(SIZE AND TYPE INDICATED)

EXISTING POLE (ANY TYPE AS INDICATED)

NEW POLE (ANY TYPE AS INDICATED)

40 C PILOT ------

◆ 27W 3L <> 80W 4C

♦ 135W 5L
♦ 155W 6C

250W HPS 🛕 250W MH

CONCRETE

HV CABLE PIT P# P# - TYPE
B/D - TRAFFICABLE

☐ 100/200AMP CUTOUT

SERVILED UNCLE.....
DE-ENERGISED LOT SERVICED UNCLEARED

EXISTING SUDL LOT, TO BE ENERGISED NOW

250W HPS AERODROME

UMS PIT

DECORATIVE

<>> 17₩ 1A

<→ 42W 3A

100₩ 5C

/<u></u> 150w MH

LID RATING

LED 4000K

CN51 - 50mm2 (1c) -----

SCHEME BDY.

RETAINING WALL

RETAINING WALL

EXTRA FOOTING

EASEMENT

RESTRICTED ZONE

EXISTING HV CABLES

CN45 - 240mm2 (1x3c)

CN44 - 185mm2 (1x3c)

CN43 - 120mm2 (1x3c)

CN42 - 25mm2 (1x3c)

CN41 - 16mm2 SL (1c)

EXISTING LV CABLES

(SIZE AND TYPE INDICATED)

ROAD FLAIR

◆ 16W 1E

<▶ 43W 2E

◆ 140W 5E

◆ 165W 6E

◯ 42W CFL

() EXISTING

UNIVERSAL

STANDARD WE

CUSTOM FOOTPATH

CABLE MARKER PLATE

CONDUIT / POLY PIPE

MINI

LINK

MINI (WORKING END)

(SIZE AND TYPE INDICATED)

ELECTRICAL NETWORK

heet Of | 3E Drawing Number 3E22009-01