

CONTRACTOR NOTES:

- DRAWING TO BE READ IN CONJUNCTION WITH CONTRACT DRAWINGS AND SPECIFICATIONS.
- ALL WORKS TO BE COMPLETED IN LINE WITH WESTERN POWER POLICIES, INCLUDING THE UDS, WADCM, DDC, DSM, DCSH, UCIM AND EARTHING FAQ. ALL MATERIALS USED MUST BE APPROVED WESTERN POWER MATERIALS.

ALWAYS REFER TO CURRENT DBYD DRAWINGS. POTHOLE

VERIFY ALL MATERIAL QUANTITIES AGAINST SITE CONDITIONS PRIOR TO QUOTATION AND ADVISE ELECTRICAL CONSULTANTS OF ANY VARIATIONS. SHOW CAUTION IN PROXIMITY TO EXISTING ASSETS.


TO LOCATE IF NECESSARY. PROTECT SERVICES AS

- REQUIRED. DO NOT ENCROACH MINIMUM APPROACH DISTANCES FOR UNDERGROUND OR OVERHEAD ASSETS. LIAISE WITH WESTERN POWER AS REQUIRED. ORGANISE PRE-HANDOVER INSPECTION AND ENERGISATION SCHEDULE WITH ELECTRICAL SUPERINTENDENT/
- INSPECTOR PRIOR TO COMPLETION OF WORKS. CONTRACTOR TO COMPLETE & PROVIDE AS CONSTRUCTED PACKAGE AS PER UDS. ENGAGE 3E CONSULTING ENGINEERS TO DRAFT WP COMPLIANT CAD AS CONS DRAWINGS. INCLUDE 3E'S COSTS FOR DRAFTING AS CON DRAWINGS IN TENDER PRICE, MAINTAIN AND PROVIDE COMPLETE CLEAR & LEGIBLE RED-LINE AS CONSTRUCTED DRAWING MARK-UPS
- TO 3E CONSULTING ENGINEERS. MAKE ALLOWANCE FOR TERRACING OF CABLES WHERE REQUIRED, INCLUDING FOR ROAD CROSSINGS
- CLEAN BEDDING SAND TO BE IMPORTED FOR CABLE TRENCHES WHERE EXISTING MATERIALS DO NOT MEET WP REQUIREMENTS.
- . PLAN CABLE RUNS TO LIMIT THE NUMBER OF STRAIGHT
- O. COMMENCE LAYING CABLES FROM THE TRANSFORMER, SWITCHGEAR OR UNIVERSAL PILLAR.
- ALL CABLES LAID NEXT TO RETAINING WALLS TO BE IN CONDUIT.EXTEND CONDUIT 2m PAST WALL ON STRAIGHT SECTIONS
- 2. INSTALL HEATSHRINK "END CAP" AT ALL CABLE ENDS. 13. INSTALL HEATSHRINK GLOVES ON ALL LV CABLE TERMINATION ENDS.
- 4. STREETLIGHT POLES MUST NOT BE INSTALLED IN FOOTPATHS. PEG POLES LOCATIONS PRIOR TO INSTALL AND NOTIFY 3E OF CLASHES IN ADVANCE.
- 5. ERECT LIGHT POLES ONLY AFTER NEARBY EXISTING OVERHEAD POWERLINES ARE REMOVED, WHERE NOTED.
- 6. BORE UNDER EXISTING ROADS. 7. CONTRACTOR TO LEAVE SUFFICIENT CABLE COILED AT ALL INTERFACE POINTS (INCLUDING JOINTS, PILLAR TERMINATIONS & POLE TERMINATIONS) TO ALLOW WP TO COMPLETE INTERFACE WORKS. INSTALL END CAPS TO PROTECT CABLE.CONTRACTOR TO BRING NEW CABLE ADJACENT TO EXISTING CABLE AND POT-HOLE TO
- EXPOSE EXISTING CABLES FOR WP AT HANDOVER 8. HV FEEDER CABLES TO BE INSTALLED AT DEPTHS SHOWN IN TRENCH CROSS SECTIONS, TO ALLOW FOR
- CLEARANCES TO OTHER AND FUTURE CABLES. 9. CONTRACTOR TO INSTALL SL CABLE ON 2.7m ALIGNMENT

WESTERN POWER SCOPE OF WORKS


- (A) WP TO COST TO CUT EXISTING 400HV CABLE AT LOT 2563 AS SHOWN AND REMOVE/ABANDON REDUNDANT CABLE TO POLE #8444670.
- B) WP TO COST TO REMOVE ALL AERIAL ASSETS BETWEEN POLE #8444670 AND POLE #198526.POLE #8444670 TO BE REMOVED. WP INSTALL HV TERM SELF SUPPORTING POLE AS REQUIRED AND CARRY OUT ALL ASSOCIATED WORKS.
- WP TO COST TO TERMINATE NEW 400HV CABLE TO EXISTING POLE #198526, WP TO SUPPLY TERMINATION
- AND CARRY OUT ALL ASSOCIATED WORKS. WP TO COST TO CARRY OUT REMOVAL OF EXISTING SEALED END AND STRAIGHT JOINT NEW 240LV CABLE TO EXISTING 240LV CABLE, WP TO EXCAVATE AND BACKFILL JOINT BAY AND SUPPLY JOINT.
- WP TO COST TO CARRY OUT REMOVAL OF EXISTING SEALED END AND STRAIGHT JOINT NEW 35 3C HV CABLE TO EXISTING 35 3C HV CABLE, WP TO EXCAVATE AND BACKFILL JOINT BAY AND SUPPLY JOINT
- F) WP TO COST TO STRAIGHT JOINT NEW 400HV CABLE TO EXISTING 400HV CABLE, WP TO EXCAVATE AND BACKFILL JOINT BAY AND SUPPLY JOINT.



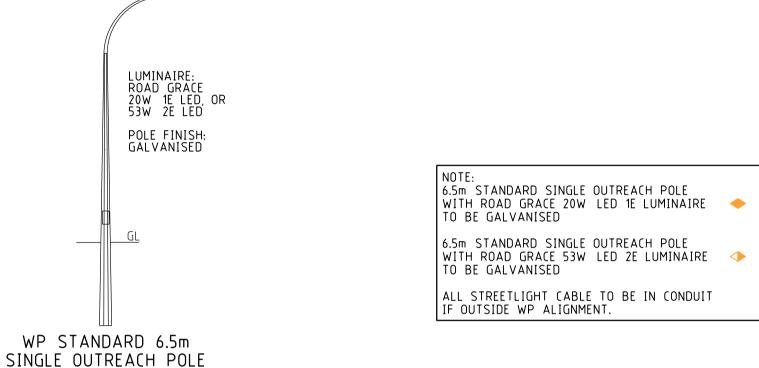

NOTE: ALL UNMETERED SUPPLIES (Including CUSTOMER AND WESTERN POWER STREETLIGHTING ASSETS)						
I YDE DE EDITIONENT	NO of UNITS			DAILY HRS OPERATION		
6.5m WP STANDARD POLE + ROAD GRACE 20W LED 1E (3000K) LUMINAIRE	8	20W	160W	DUSK/DAWN	YES	
6.5m WP STANDARD POLE + ROAD GRACE 53W LED 2E (3000K) LUMINAIRE	7	53W	371W	DUSK/DAWN	YES	
NOTE ALL UNMETERED SUPPLIES and STREETLIGHTS MUST BE INCLUDED IN DESIGN DRAWING						

NOT TO SCALE

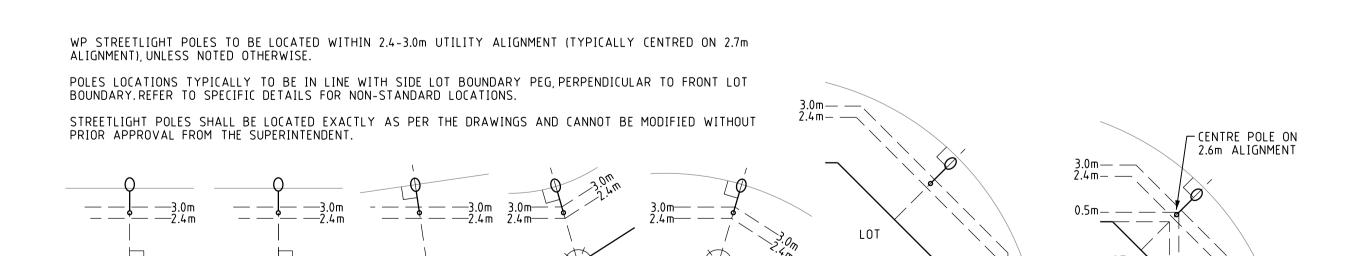

ROAD BEND

TYPICAL STREETLIGHT POLE LOCATIONS NOT TO SCALE

LOT B

CONSULTING

LOT B

LOT A

KERB NOT PARALLEL

WITH FRONT LOT

BOUNDARY

LOT A

ROAD BEND

Suite 1, Level 2, Condor Tower 22 St George's Tce, Perth WA 6000 PO Box 3184 East Perth WA 6892 Tel: 08 6314 9000 Email: admin@3ece.com.au

Electrical Engineering Excellence document is prohibited. Any modification to this drawing will be subject to further technical input.

CORNER/INTERSECTION


(TYPICALLY 8.5m TRUNCATION)



CORNER/INTERSECTION

(REDUCED 4.25m TRUNCATION)



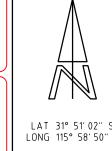

\bigwedge	0 5				
T 31° 51′ 02″ S G 115° 58′ 50″ E	Scale				
	Base File Date				
	Designed: TM				
	Western Power Reference No.				
	Local Authority				
	Civil Consultant				

a A1 Original Paper Size 30.08.2021 H. Datum PCG94 Drawn: **TM** Checked: **JH** Appr: **JH** MS018382 WAPC No. 160731 CITY OF SWAN TABEC

SCHEME BDY. ____ RETAINING WALL RETAINING WALL EXTRA FOOTING RESTRICTED ZONE EASEMENT HV CABLES CN53 - 400mm2 (3X1c) — — — — — -(N49 - 240mm2 (3X1c) — — — — — -CN48 - 185mm2 (3X1c) — — — — — — CN50 - 95mm2 (3X1c) — — — — -

LEGEND

CN51 - 50mm2 (3X1c) — — — — — — CN51 - 50mm2 (1c) CN46 - 35mm2 (3X1c) — — — — — -CN47 - 35mm2 (1c) -----EXISTING HV CABLES (SIZE AND TYPE INDICATED) LV-SL CABLES CN45 - 240mm2 (1x3c)

CN44 - 185mm2 (1x3c) CN43 - 120mm2 (1x3c) CN42 - 25mm2 (1x3c) CN41 - 16mm2 SL (1c) EXISTING LV CABLES (SIZE AND TYPE INDICATED) STREET LIGHTS EXISTING (*)

◯ 42W CFL 📦 70W HPS 🛆 70W MH 🔷 20W LED 1L 80W MV 150W HPS 150W MH 53W LED 2L 125W MV 250W HPS 250W MH 36W LED 3L 250W HPS AERODROME S160W LED 5L ◆ 170W LED 6L LEGEND DEFINES TYPE & WATTAGE - NOT COLOUR

PILLARS / PITS / ETC ☐ MINI (WORKING END) ☐ UMS PIT UNIVERSAL CONCRETE MINI P# P# - TYPE B/D - TRAFFICABLE LINK STANDARD WP

☐ 100/200AMP CUTOUT MARKER POST SERVICED UNCLEARED DE-ENERGISED LOT CUSTOM FOOTPATH CABLE MARKER PLATE CONDUIT / POLY PIPE TRANSFORMER EXISTING SWITCHGEAR

AERIAL CONDUCTORS AND POLES NEW POLE (ANY TYPE AS INDICATED) EXISTING POLE (ANY TYPE AS INDICATED) EXISTING AERIAL CONDUCTORS (SIZE AND TYPE INDICATED)

129BA RESTRICTED COVENANTS REQUIRED ON LOTS ADJACENT TO SUBSTATION SITE, AS SHOWN BELOW, FOR FIRE SEPARATION AS PER UDS MANUAL AND DISTRIBUTION SUBSTATION MANUAL. COVENANTS NOT REQUIRED

HYDROLOGY DATA (LEVELS AHD)

1:100 YEAR ARI FLOOD | TBA

DRINKING WATER AREA TBA

- BOX CULVERT - CROWN AND BASE TYPE

NOMINAL SIZE = $1200 \times 900 \times 1220 \text{ LONG}$

SUBSTATION SITE

CROWN WEIGHT = 948 kg

BASE WEIGHT = 384 kg

SEE DRAWING DSPM 4-02

FOR INSTALLATION DETAILS

FOR INSTALLATION DETAILS

COMBINED EARTHING SYSTEM

BURIED 150mm BELOW FGL

MPS TRANSFORMER SEE DSPM 3-01

EARTHING GRID TO AS/NZS 2067:2008

GROUNDWATER

OIL BUND WALL

PROPERTY BOUNDARY

ROAD RESERVE

TYPICAL 22kV SUBSTATION DETAIL

WITH 630kVA MPS TRANSFORMER

LOCATED ON POS 8030

NOT TO SCALE

SUBSTATION SITE REQUIREMENTS:

F ROAD RESERVE OR POS.

4100mm

3700mm⁻

200mm

200mm

THE SUBSTATION SITE MUST BE INCORPORATED AS AN EXTENSION


THE CONTRACTOR MUST CONSTRUCT THE SUBSTATION SITE IN LINE WITH THE CIVIL DESIGN AND WP'S REQUIREMENTS, INCLUDING, BUT NOT LIMITED TO: EXCAVATING AND BACKFILLING WITH APPROPRIATE MATERIALS, PROVIDING APPROVED SURFACE

THE SUBSTATION LOCATION HAS BEEN CHOSEN AND DESIGNED TO

MEET SPECIFIC REQUIREMENTS, INCLUDING: NETWORK, CIVIL, EARTHING & EPR, BUILDING FIRE CLEARANCES AND NOISE REQUIREMENTS. DO NOT MODIFY ANY ASPECT OF THE SUBSTATION OR THE SUBSTATION SITE, INCLUDING EARTHING, WITHOUT PRIOR APPROVAL OF THE SUPERINTENDENT AND ELECTRICAL ENGINEER.

REFER TO THE LATEST VERSIONS OF WP'S UDS, WADCM, DSM, DDC AND EARTHING FAQ DOCUMENTS FOR DETAILS OF REQUIREMENTS.

TREATMENTS AND MINIMUM EARTHING REQUIREMENTS.

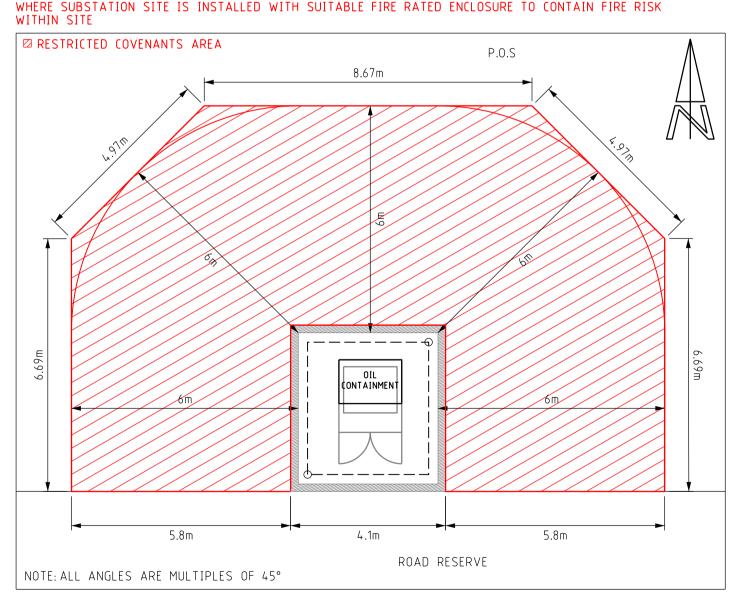

TYPICAL 630kVA MPS TRANSFORMER RESTRICTED FIRE COVENANTS DETAIL SCALE 1:100

ST LEONARDS ESTATE, DAYTON - STAGE 1V 51 RESIDENTIAL LOTS ELECTRICAL NETWORK

sheet Of 3E Drawing Number 3E21097-01

ISSUED TO CLIENT FOR COMMENT 01.10.2021 TM DATE DRWN CHKI DESCRIPTION

LOT B

STRAIGHT ROAD

LOT A / LOT B

BOUNDARY NOT

PERPENDICULAR TO

FRONT BOUNDARY

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